STRUCTURAL ENGINEER NOTES:

• PLANS BONDED BY:

MARCEL PAPINEAU, P.E. INTELLIGENT DESIGN ENGINEERING 1945 J N Pease PI, #204 Charlotte, NC 28262 704.335.7200 http://idecharlotte.com/ Email: Marcel@IDEcharlotte.com





FOUNDATION, BEAMS & POSTING WORK NOTES: CONSULTING & CONSTRUCTION WITH:

Craig Scanlon R.E. Burns & Sons Co., Inc. P.O. Box 7168 Statesville, NC 28687

704-881-3135

https://www.reburns.com/REBurns.htm craig.reburns@gmail.com

TREE HARDWARE USED TO SUPPORT BEAM IN TREES & GENERAL TREEHOUSE INFORMATION NOTES:

• CONSULTING & DIRECTION WITH:

Daryl McDonald Nelson Treehouse and Supply (Treehouse Masters) PO Box 1135 Fall City, WA 98024 www.nelsontreehouse.com


TREE INSPECTION NOTES:

- TREE #1 RED OAK
- TREE #2 WHITE OAK
- BOTH TREES INSPECTED AND FOUND SOUND TO BUILD IN (REPORT SUBMITTED FOR REFERENCE):

John A Maurice Heartwood Tree Service LLC ISA Board Certified Master Arborist SO-5414BT ISA Qualified Tree Risk Assessor john@heartwoodtree.com

GENERAL NOTES:

- STANDARD STUD FRAMING 2"X4" @ 16" O.C. UNLESS OTHER-**WISE INDICATED**
- 7/16" OSB EXTERIOR W ALL SHEATHING AND FELT ROOF UNDER-LAYMENT AS HOUSE WRAP
- NUMBER OF STAIR TREADS AND RISERS MAY VARY AS A RESULT OF LOCAL BUILDING CODES, STANDARDS AND FINAL GRADE
- BOARD AND BATTEN EXTERIOR IN ROUGH CUT LUMBER OR RECLAIMED LUMBER
- ALL PLUMBING FIXTURES SHOWN ARE A REPRESENTATION OF SIZE AND LOCATION ONLY. ACTUAL BRAND AND STYLE OF FIXTURES MAY VARY PER OFFICE LOCATION
- R-15 INSULATION IN WALLS
- R-38 INSULATION IN ROOF

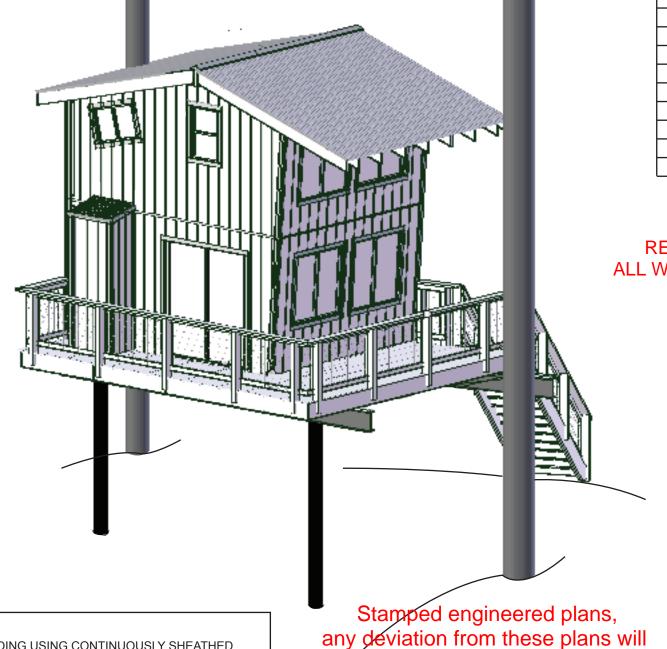

SHE	ET LIST CONSTRUCTION
SHEET NUMBER	SHEET NAME
C.0	COVER SHEET
FR.2	FRONT & REAR ELEVATIONS
LR.2	LEFT & RIGHT ELEVATIONS
TBF.1	TREE, BEAM FOUNDATION &
	FIRST FLOOR JOIST LAYOUT
TBP.2	TREE, BEAM & POST ELEVATION
S.1.1	FIRST FLOOR PLAN
S.1.2	LOFT JOIST LAYOUT
S.1.3	LOFT PLAN
S.1.4	ROOF JOIST LAYOUT
S.1.5	ROOF PLAN
S.5.1	FRONT WALL FRAMING DETAILS
S.5.2	LEFT WALL FRAMING DETAILS
S.5.3	RIGHT WALL FRAMING DETAILS
S.5.4	DETAILS 1
S.5.5	DETAILS 2
S.6	SCHEDULE DETAILS

REVIEWED FOR CODE COMPLAINCE ALL WORK SUBJECT TO FIELD INSPECTION

AREAS	
FIRST FLOOR HABITABLE	145.8 SQ. FT.
GROSS FLOOR AREA	
LOFT HABITABLE	112.5 SQ. FT.
GROSS FLOOR AREA	

FIRST FLOOR HEATED	173 SQ. FT.
LOFT HEATED	112.5 SQ. FT.
TOTAL HEATED	285.5 SQ. FT.
COVERED FRONT DECK	76.8 SQ. FT.
COVERED READING NOOK/	11.6 SQ. FT.
OUTDOOR SHOWER AREA	
TOTAL UNHEATED	88.4 SQ. FT.
UNDER ROOF	
TOTAL UNDER ROOF	373 9 SQ FT

BRACED WALL LINE NOTE:

THIS STRUCTURE HAS BEEN ANALYZED FOR LATERAL LOADING USING CONTINUOUSLY SHEATHED 7/16" OSB WALL SHEATHING USING 8d NAILS AT 6" O.C. ALONG EDGES AND 12" O.C. AT INTERMEDIATE FRAMING. BLOCK AND NAIL ALL PANEL EDGES.

WHERE BRACED WALLS DO NOT MEET THE PRESCRIPTIVE REQUIREMENTS OF SECTION R602.10 OF THE CODE, IT HAS BEEN ANALYZED BY ENGINEERING ANALYSIS INCORPORATING ENGINEERED LATER-AL BRACING ELEMENTS WHERE NEEDED TO MEET THE INTENT OF THE CODE. SEE PLANS FOR ALL NOTES AND DETAILS.

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Scale: 3/16" =1'- 0

Paper: 11"x17"

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Sheet Number:

C.0

COVER

SHEET

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also require a sealed design change

GENERAL NOTES: ELEVATION NOTES: • ALL WINDOWS ARE VINYL UNLESS OTHERWISE INDICATED • ROOF OVERHANGS, AS NOTED, ARE FROM WALL SHEATHING TO RAFTER TAILS • RAILINGS SHOW N ON ELEVATIONS ARE FOR ILLUSTRATION PURPOSES ONLY, ACTUAL RAIL DETAIL WILL VARY PER LOCATION FRONT ELEVATION TREE #1 TREE #2 LINE OF WALL **BEYOND CONTINUOUS** RIDGE VENT **ROOFING AS** LINE OF WALL 3'-8" **SPECIFIED** BEYOND **ROOFING AS SPECIFIED** 17'-2" **EXTERIOR AS** SPECIFIED 13'-6" 30'-2" 1'-0" 13'-0" 12'-0"






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REAR ELEVATION



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FR.2

FRONT &
REAR
ELEVATIONS

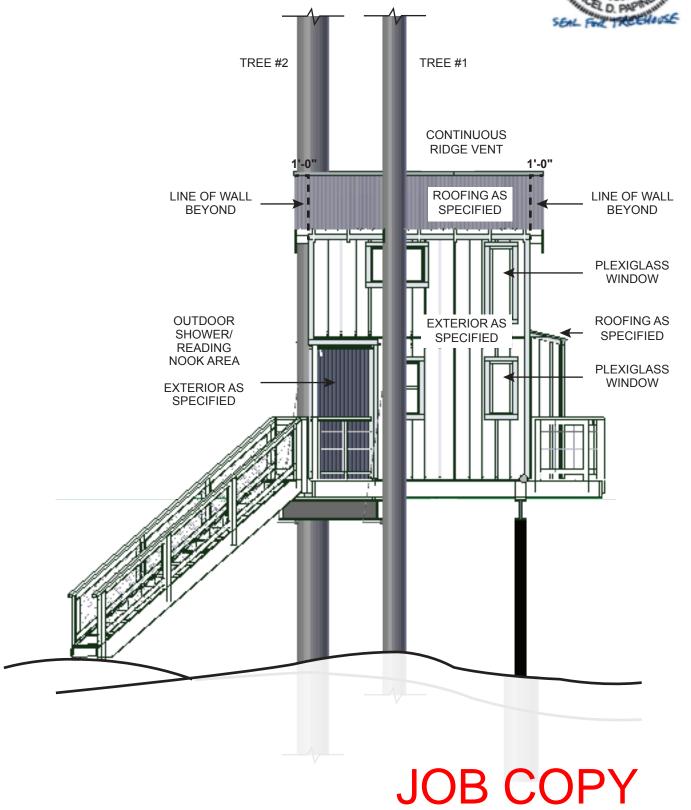17'-2"

11'-0"

28'-2"

13'-6"

1'-0"

10'-0"

• ALL WINDOWS ARE VINYL

TREE #1

ELEVATION NOTES:

LEFT ELEVATION

- MINIMUM 7'-7" CEILING HEIGHT ON FIRST FLOOR
- MINIMUM 7'-11" CEILING HEIGHT ON LOFT FLOOR

12" 4"

EXTERIOR AS

SPECIFIED

- ROOF OVERHANGS, AS NOTED, ARE FROM WALL SHEATHING TO RAFTER TAILS
- RAILINGS SHOW N ON ELEVATIONS ARE FOR ILLUSTRATION PURPOSES ONLY, ACTUAL RAIL DETAIL W ILL VARY PER LOCATION

TREE #2

3'-8"


13'-6"

1'-0"

17'-2"

13'-0"

30'-2"

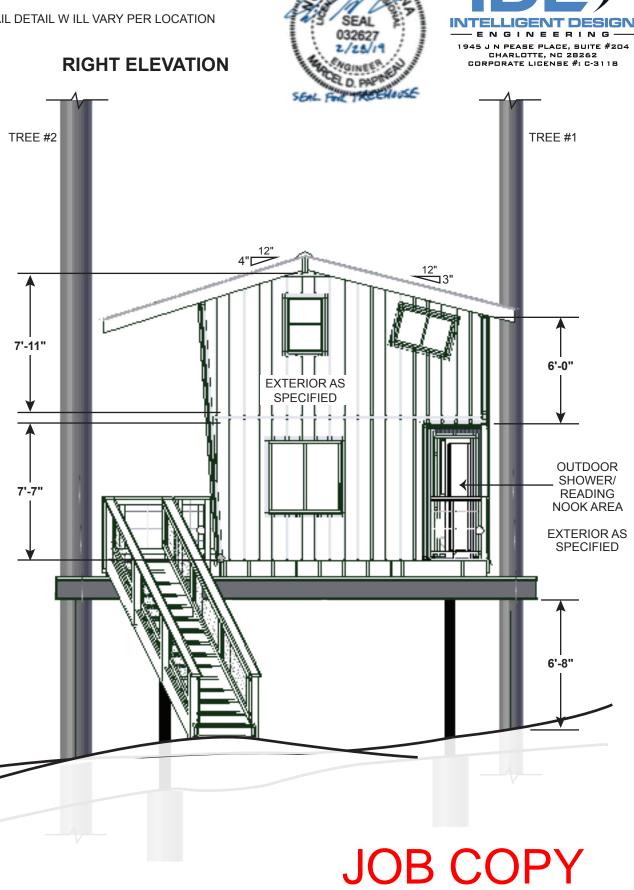

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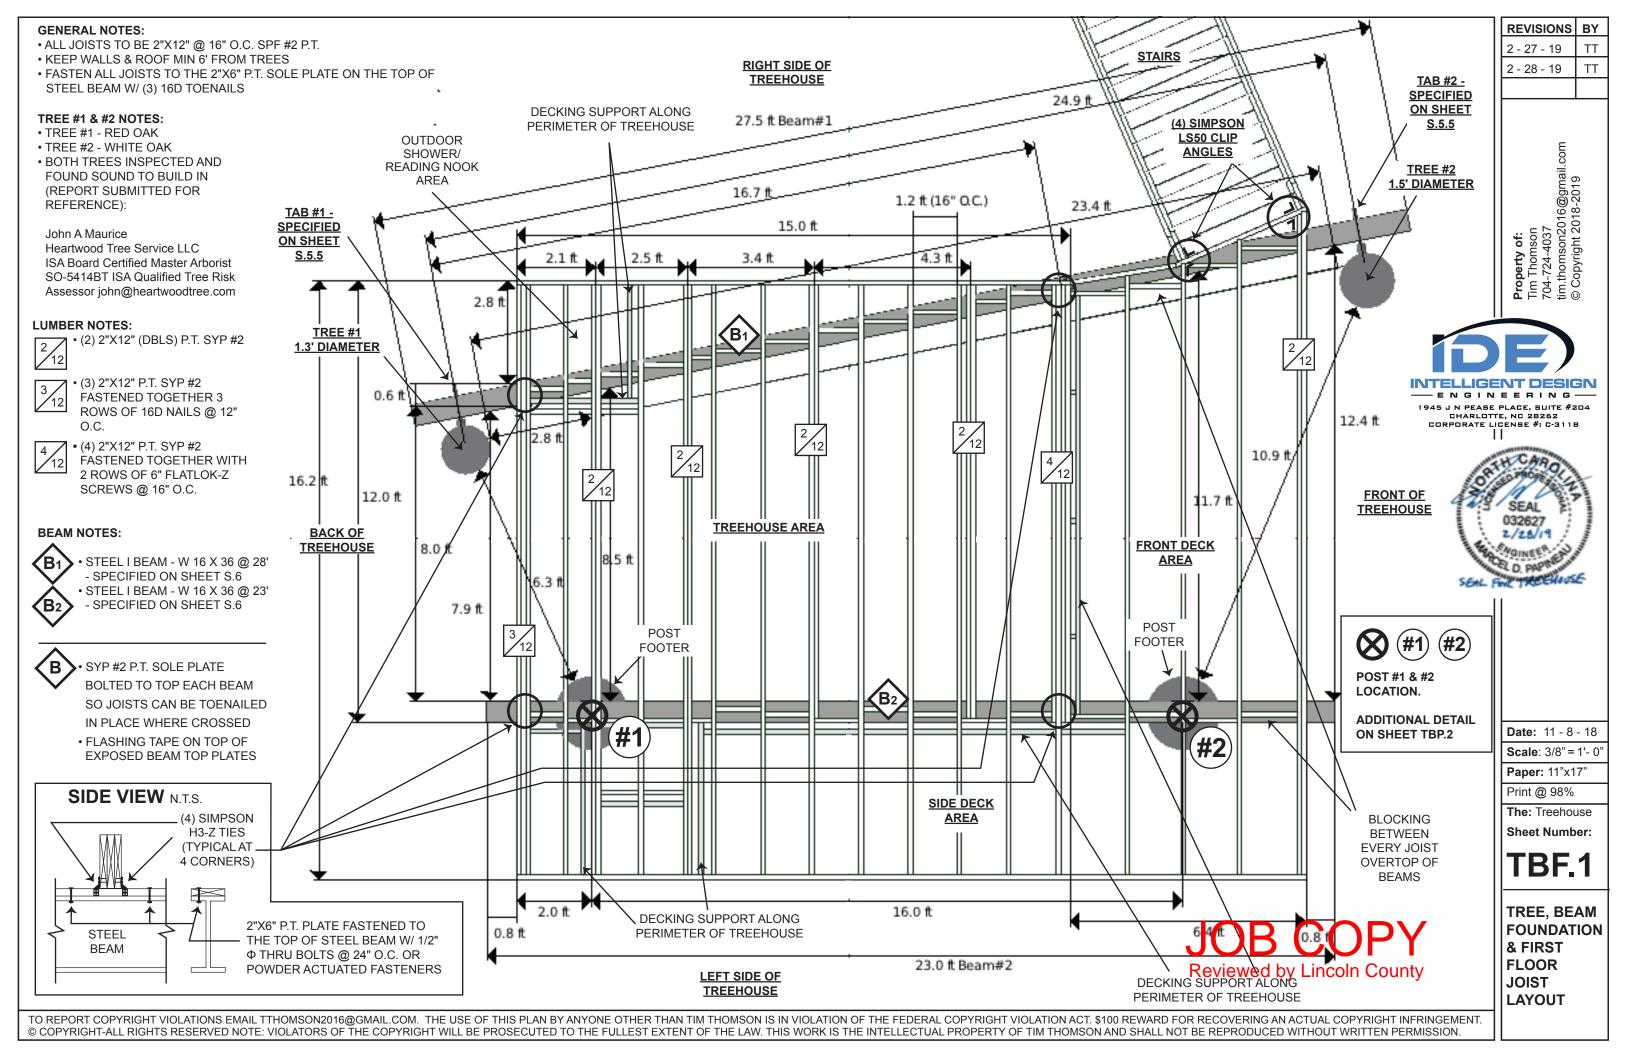
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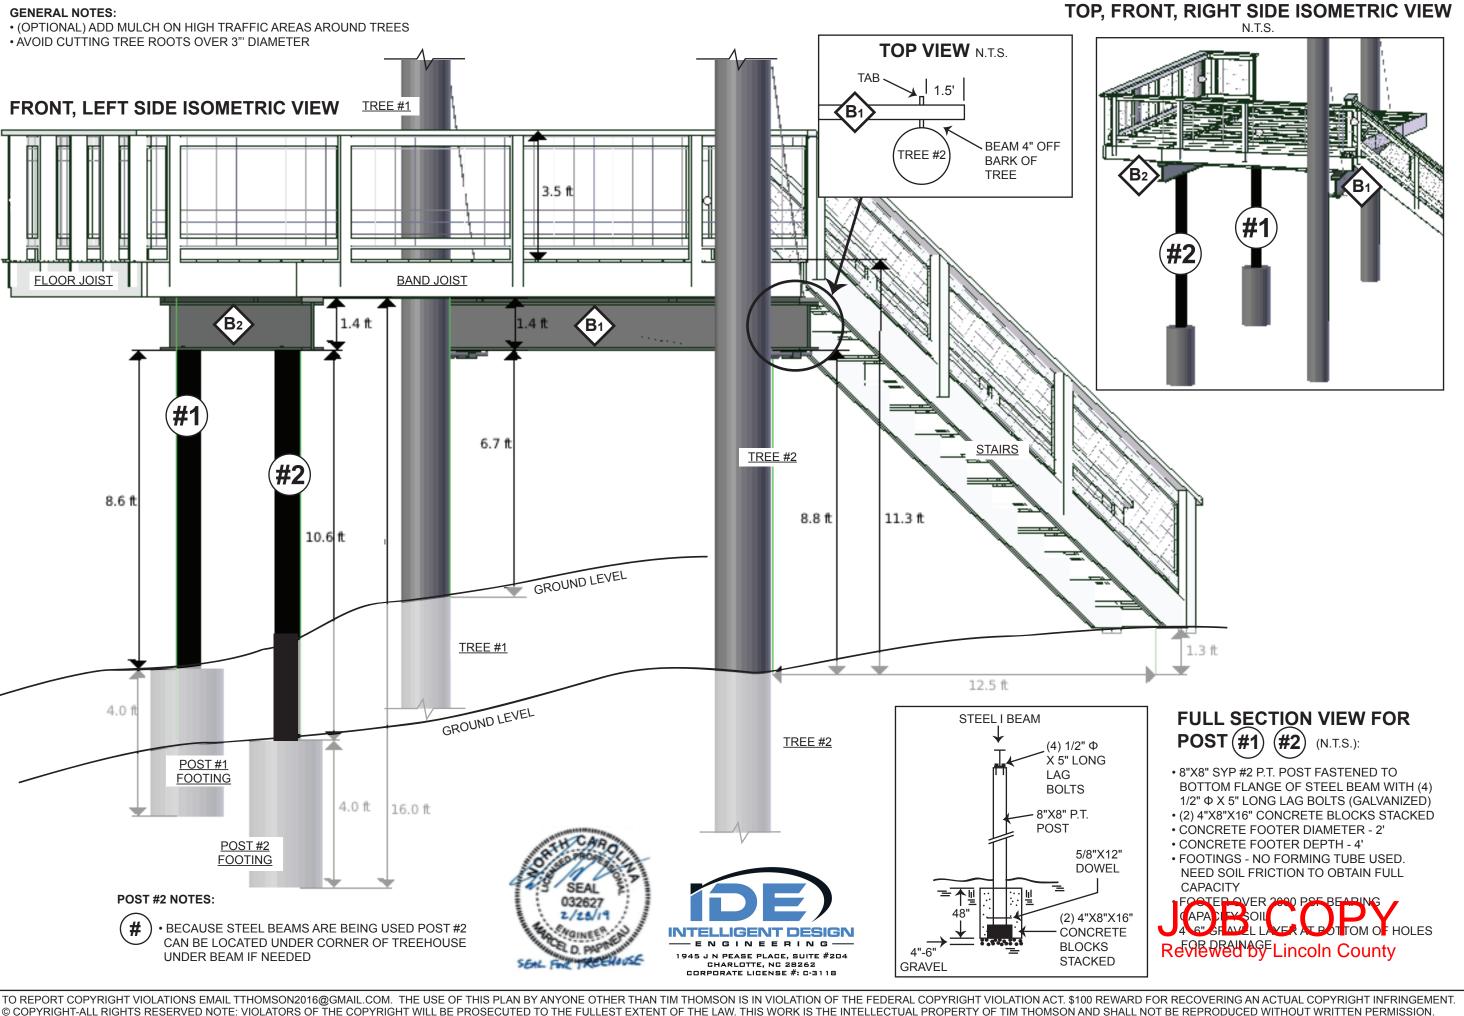
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LR.2

LEFT & RIGHT ELEVATIONS





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TBP.2

TDEE BEAM

TREE, BEAM & POST ELEVATION

- P.T. 5/4"X6" USED FOR DECKING AND STEPS
- SUB FLOOR STANDARD OSB RUNNING PERPENDICULAR TO FLOOR JOISTS

STAIR NOTES:


- NUMBER OF STAIR TREADS AND RISERS MAY VARY AS A RESULT OF LOCAL BUILDING CODES, STANDARDS AND FINAL GRADE
- STAIRS OUTSIDE STRINGERS ARE (2) P.T. 2"X12" SISTERED TOGETHER
- STAIRS CENTER STRINGER (1) P.T. 2"X12"

STAIR, DECK & OUTDOOR READING NOOK/ SHOWER AREA RAILING NOTES:

- P.T. 2"X8" RAILING CAP
- GALVANIZED WELDED WIRE ROLLED FENCING (MESH SIZE 2"X4")
- P.T. 4"X6" RAILING POSTS
- RAILING POSTS FASTENED TO DECK USING - (2) FASTEN MASTER #0 X 6-1/4-IN SILVER ECOAT HEX-HEAD INTERIOR/EXTE-RIOR STRUCTURAL WOOD SCREWS
- TOP OF RAILING TO BE 36" HIGH





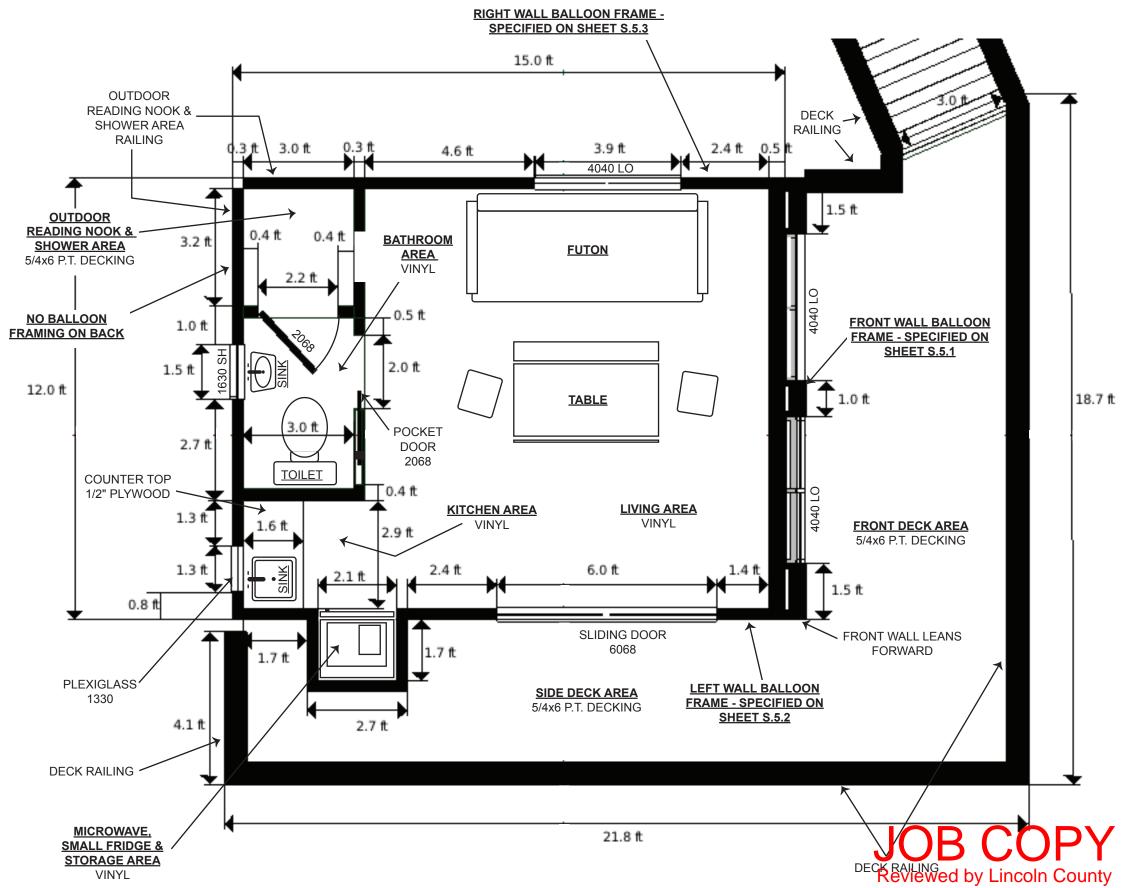

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5.1.1

FIRST FLOOR
PLAN

- \bullet ALL LOFT FLOOR JOISTS (EXCEPT FOR LOFT LATTER LANDING) TO BE (2) 2"X6" @ 16" O.C. SPF #2
- LOFT LADDER LANDING FLOOR JOISTS TO BE (1) 2"X6" SPF #2
- LOFT CROSS BEAM TO BE (2) 2"X12"


LUMBER NOTES:

• LOFT BEAM - (2) 2"X12" (DBLS) SPF #2

- ENGINEERING-

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LOFT JOISTS (2) 2"X6" (DBLS) SPF #2

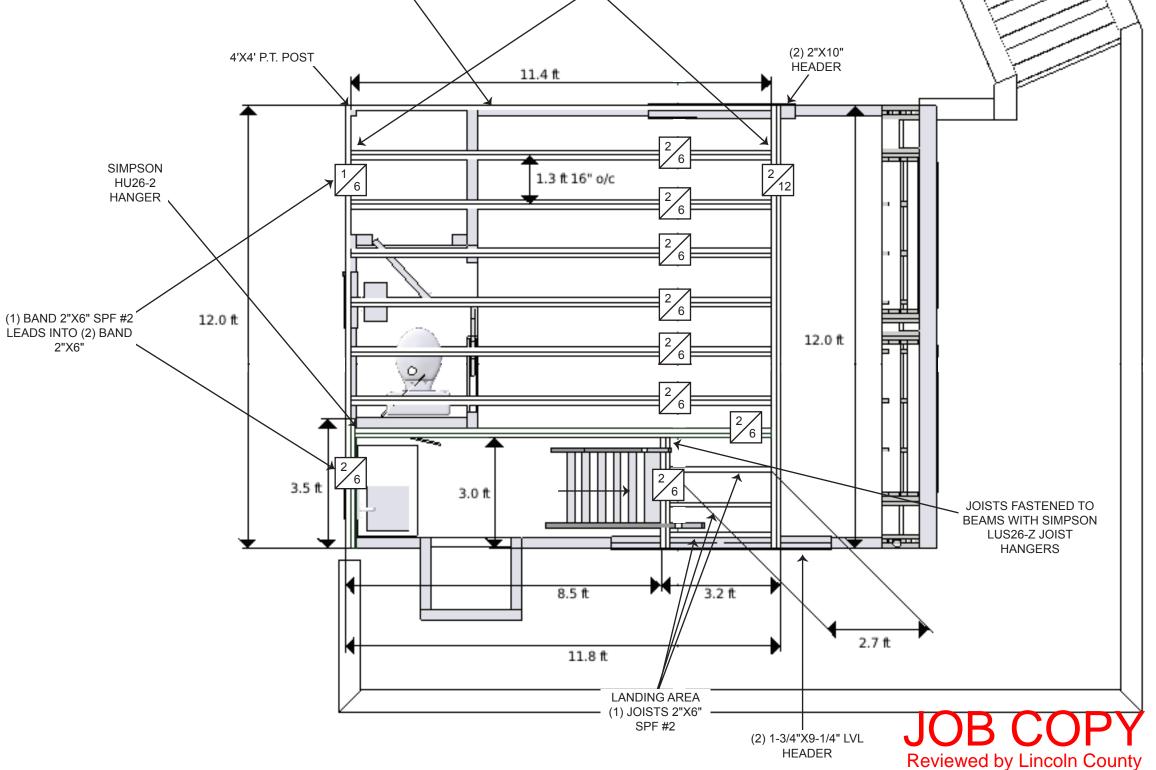

ALL JOISTS WILL BE FASTENED TO BEAMS WITH SIMPSON

LUS26-2 JOIST HANGERS

(1) BAND 2"X6"

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LOFT JOIST LAYOUT


• SUB FLOOR STANDARD 3/4" TONGUE & GROOVE PLYWOOD RUNNING PERPENDICULAR TO FLOOR JOISTS

LOFT RAILING NOTES:

- 2"X8" RAILING CAP
- GALVANIZED WELDED WIRE ROLLED FENCING (MESH SIZE - 2"X4")
- 4"X6" RAILING POSTS
- RAILING POSTS FASTENED TO DECK USING -FASTEN MASTER #0 X 6-1/4-IN SILVER ECOAT HEX-HEAD INTERIOR/EXTERIOR STRUCTURAL WOOD SCREWS

SHIPS LADDER (ACCESS TO LOFT) NOTES:

- SHIPS LADDER USED TO ACCESS THE LOFT
- SHIPS LADDER STEPS TO BE 2"X6"S
- SHIPS LADDER RAILS TO BE 2"X10"S WITH BUILT IN HANDLES

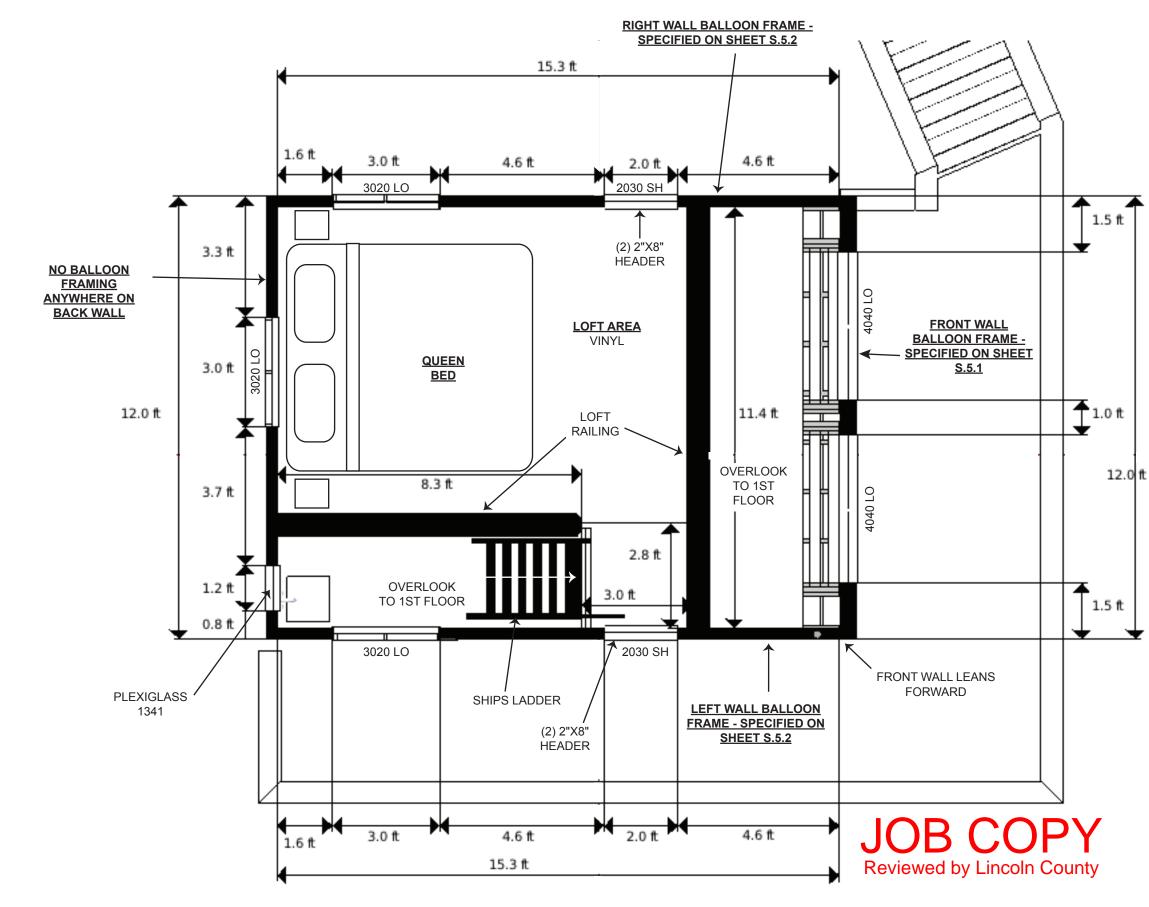





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LOFT PLAN

- RAFTERS FASTENED TO RIDGE BEAM WITH (6) 16D TOENAILS
- ALL RAFTERS TO BE 2"X10" @ 24 O.C.
- OVERHANG SOFFIT VENT BLOCKING TO OCCUR OVER WALL
- ROOF IS 3/12 PITCH ON TREEHOUSE BACK END
- ROOF IS 4/12 PITCH ON TREEHOUSE FRONT END



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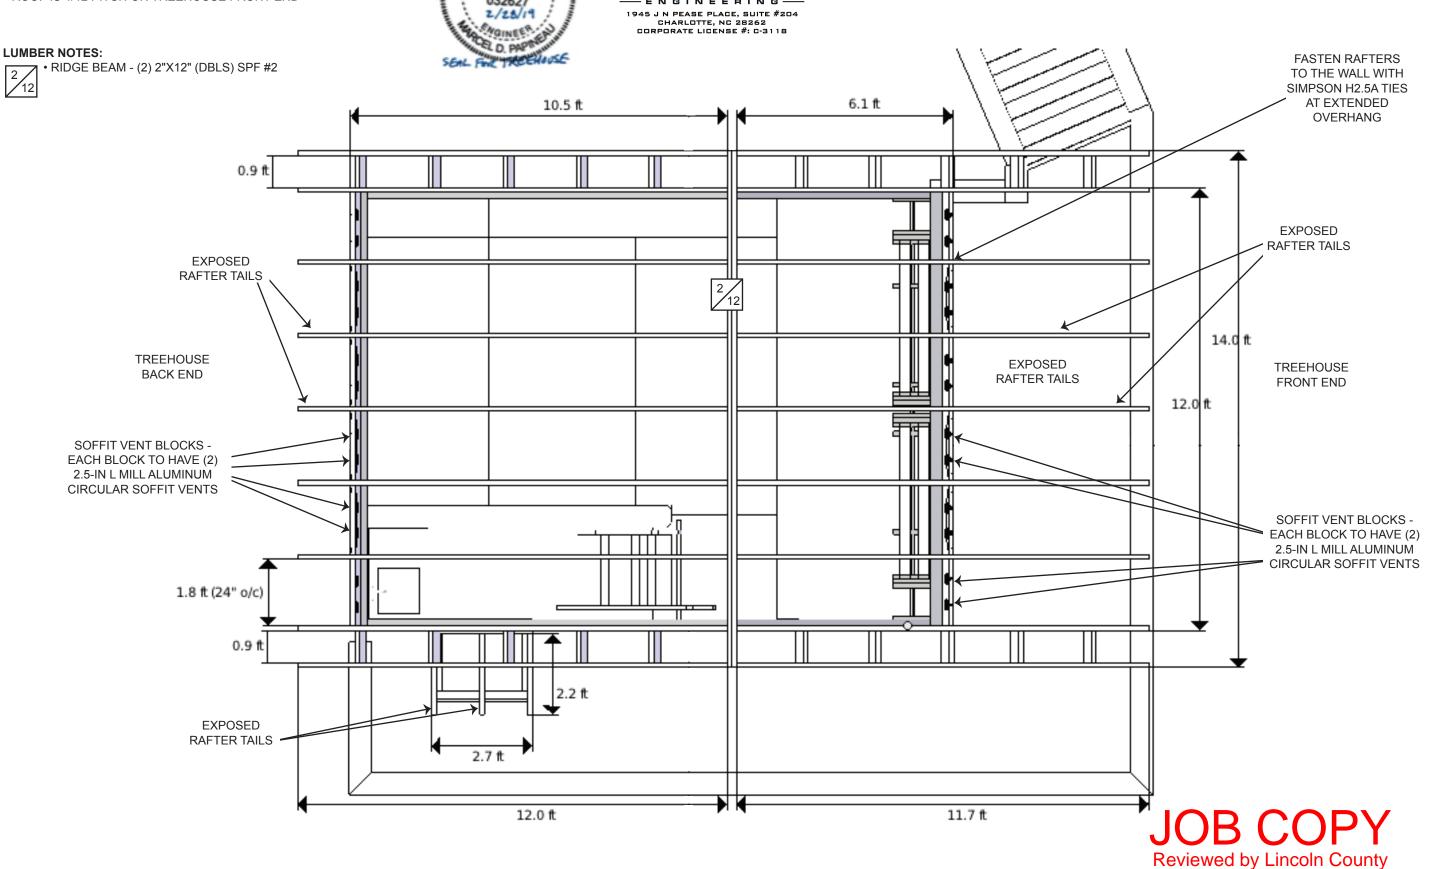
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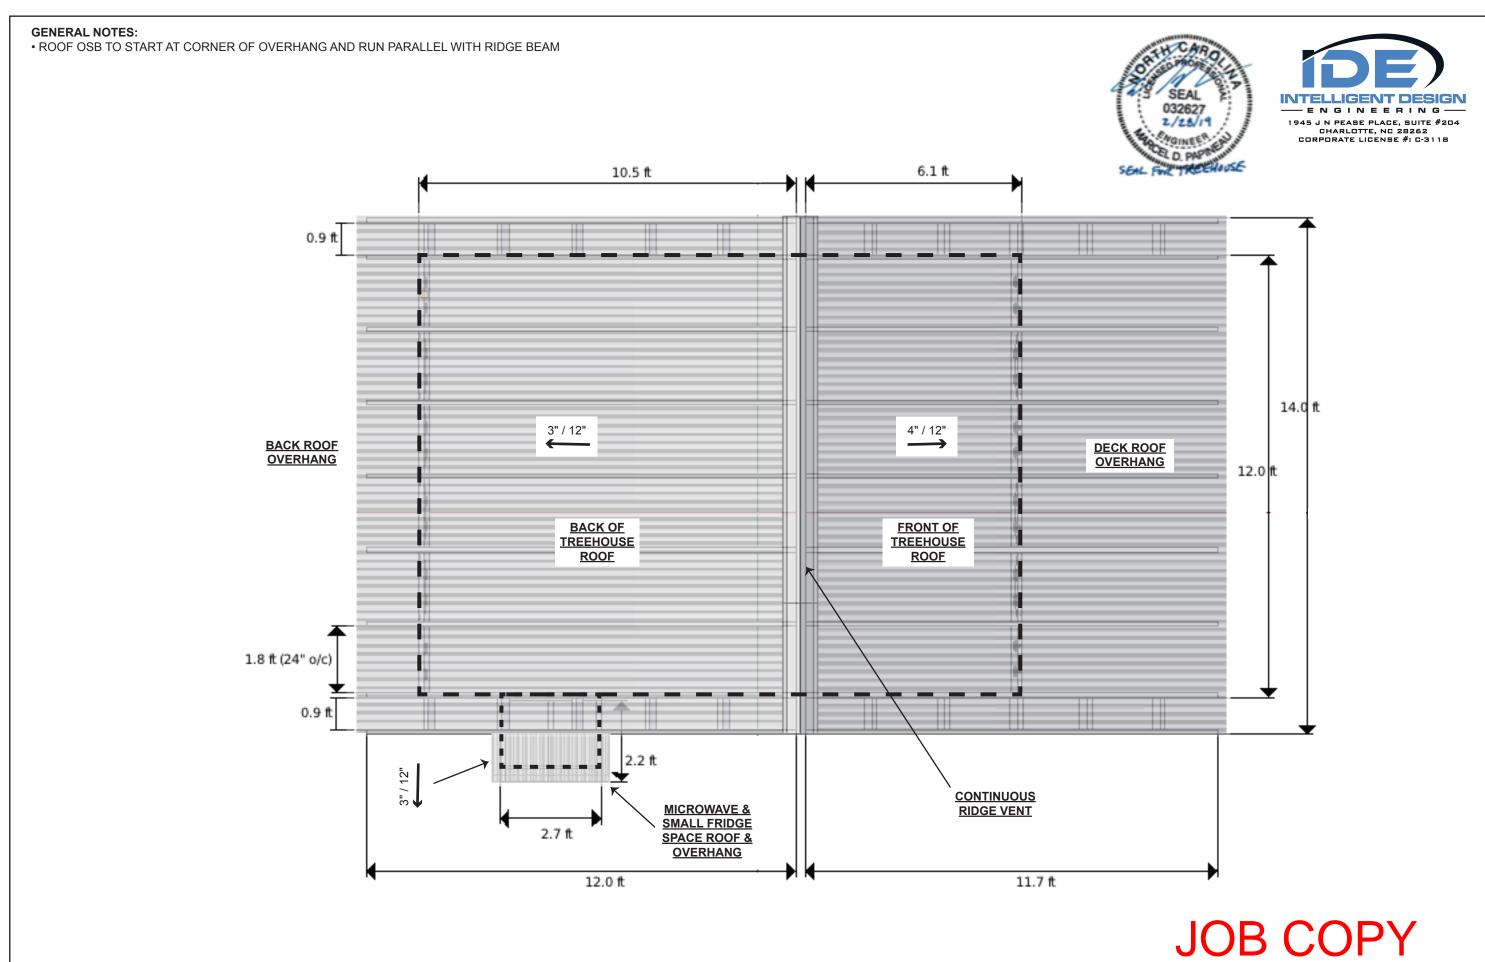
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ROOF JOIST LAYOUT





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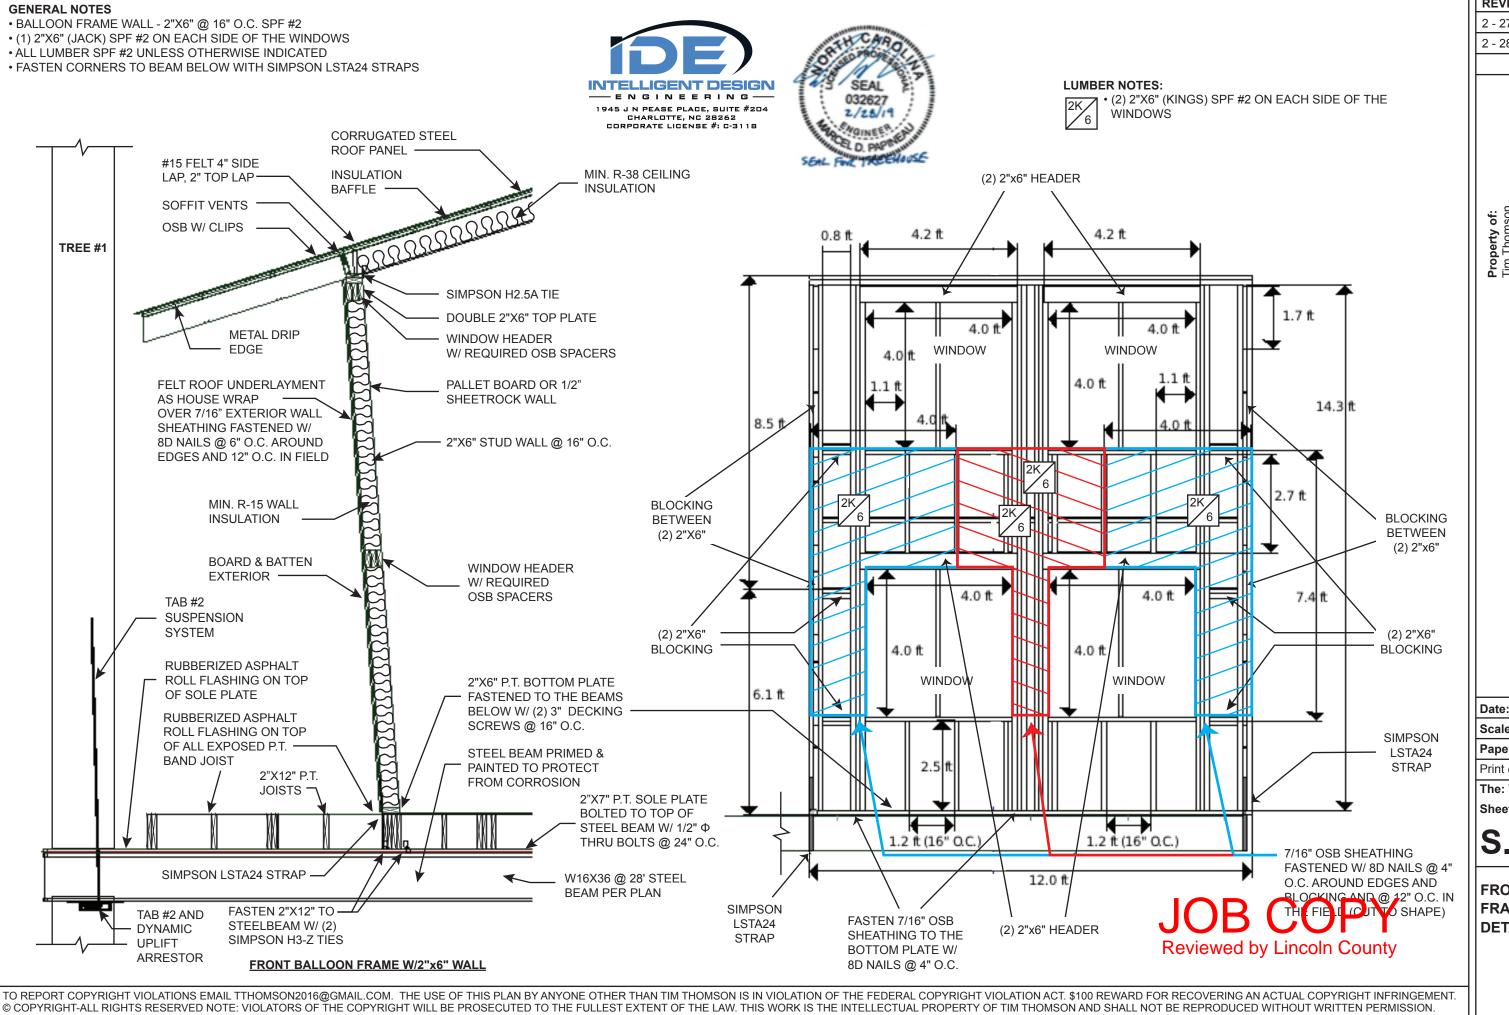
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S.1.5

ROOF PLAN

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S.5.1

FRONT WALL FRAMING DETAILS

- \bullet STANDARD STUD FRAMING 2"X4" @ 16" O.C. UNLESS OTHERWISE INDICATED
- BALLOON FRAME (2) 2"X4" @ 16" O.C. WALL
- (1) 2"X4" (JACK) ON EACH SIDE OF SECOND STORY WINDOWS
- STRAPS AT TOP LEFT AND RIGHT SIDE OF WALL TO CONNECT TO FRONT & BACK WALL
- ALL LUMBER SPF #2 UNLESS OTHERWISE INDICATED
- FASTEN BOTTOM PLATE TO JOISTS WITH (2) 3" DECKING SCREWS @ 16" O.C.
- FASTEN CORNERS TO BEAM BELOW WITH SIMPSON LSTA24 STRAPS

LUMBER NOTES:



• (4) 2"X4" (KINGS) ON EACH SIDE OF SLIDING DOOR



1 • (3) 2"X4" (KINGS)




• (2) 2"X4" (JACKS) ON EACH SIDE OF SLIDING DOOR



• (2) 2"X4" (KINGS)





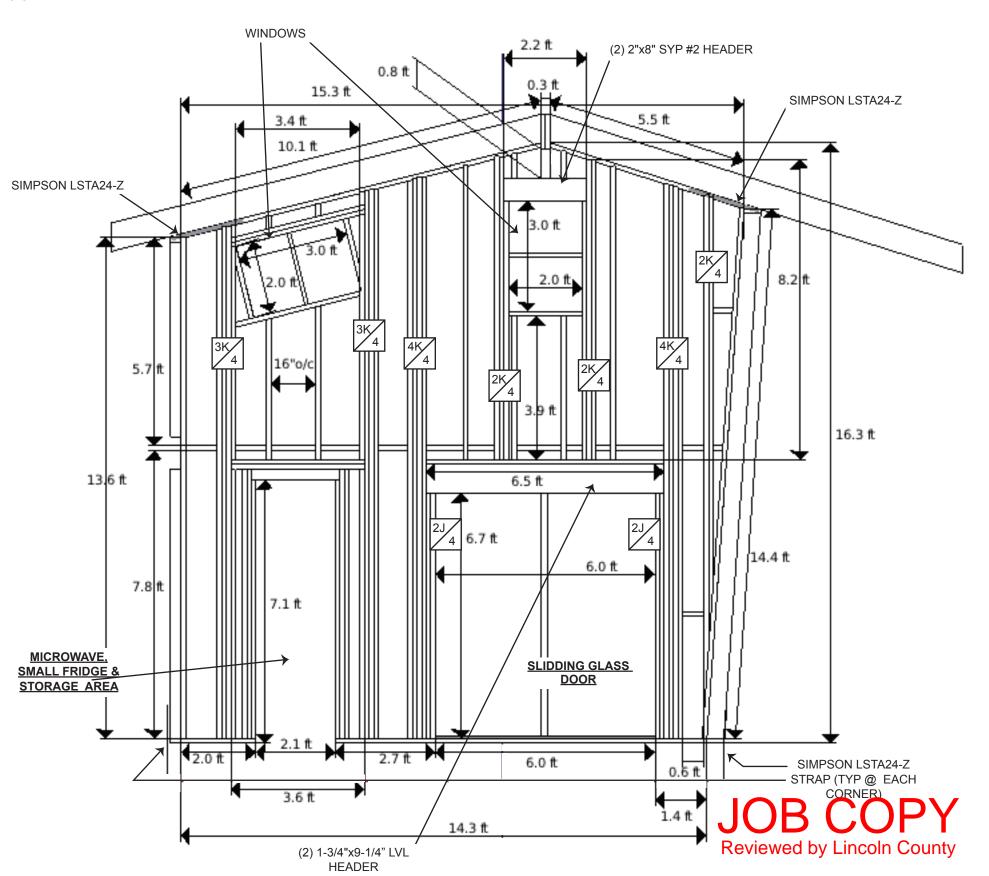

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S.5.2

LEFT WALL FRAMING DETAILS

- STANDARD STUD FRAMING 2"X4" @ 16" O.C. UNLESS OTHERWISE INDICATED
- BALLOON FRAME (2) 2"X4" @ 16" O.C. WALL
- (1) 2"X4" (JACK) ON EACH SIDE OF SECOND STORY WINDOWS
- SIMPSON LSTA24 STRAPS AT TOP LEFT AND RIGHT SIDE OF WALL TO CONNECT TO FRONT & BACK WALL
- ALL LUMBER SPF #2 UNLESS OTHERWISE INDICATED
- FASTEN BOTTOM PLATE TO JOISTS WITH (2) 3" DECKING SCREWS @ 16" O.C.

LUMBER NOTES:

4K 4

(4) 2"X4" (KINGS) ON EACH SIDE OF SLIDING DOOR




• (2) 2"X4" (JACKS) ON EACH SIDE OF SLIDING DOOR



• (2) 2"X4" (KINGS)





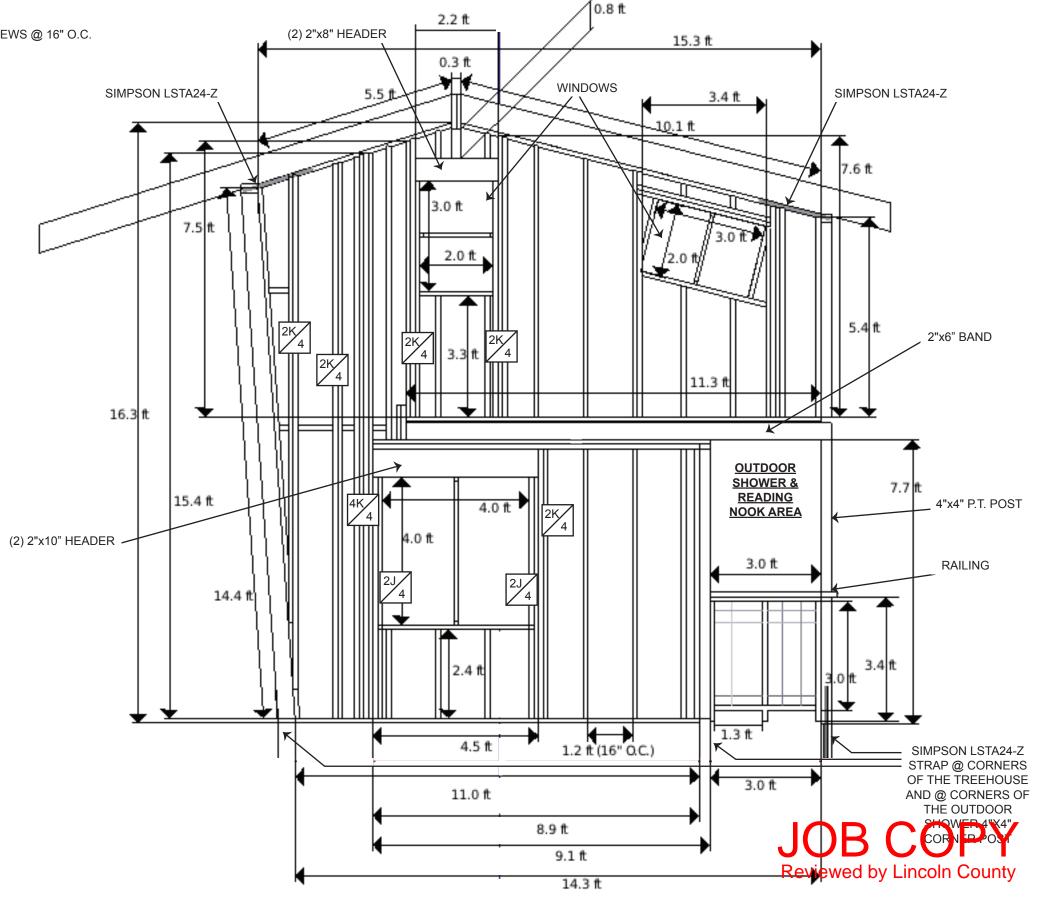

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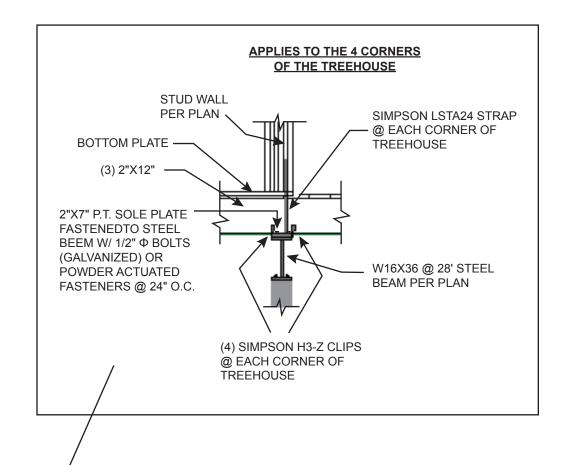
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RIGHT WALL FRAMING DETAILS





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TREE #2

#15 FELT 4" SIDE

LAP, 2" TOP LAP

SOFFIT VENTS

METAL DRIP

SHEATHING

INSULATION

BAND JOIST

STEEL ROOF)

2"X6"

MIN. R-15 WALL

EDGE

7/16" OSB W/ CLIPS

FELT ROOF UNDERLAYMENT

BOARD & BATTEN EXTERIOR

TAB #1 SUSPENSION

SYSTEM (ADDITIONAL

DETAIL ON SHEET S.5.5)

SIMPSON LSTA24 STRAP

@ EACH CORNER OF

RUBBERIZED ASPHALT

(4) SIMPSON H3-Z CLIPS

TAB #1 AND DYNAMIC UPLIFT

@ EACH CORNER OF

TREEHOUSE

ARRESTOR

TREE #2

ROLL FLASHING ON TOP OF SOLE PLATE

TREEHOUSE

(OUTDOOR SHOWER & READING NOOK

AREA EXTERIOR TO BE CORRAGATED

AS HOUSE WRAP OVER 7/16" OSB EXTERIOR WALL

CORRUGATED STEEL

INSULATION

BOTTOM

PLATE

BACK FRAME W/2"x4" WALL

BAFFLE

ROOF PANEL

WALLES TO THE TOTAL STREET, ST

SIMPSON H2.58 TIE

PALLET BOARD -

DOUBLE 2"X6" TOP PLATE

WINDOW/DOOR HEADER

OR 1/2" SHEETROCK WALL

MIN. R-15 LOFT INSULATION

OVER OUTDOOR SHOWER/

DOUBLE 2"x6" TOP PLATE

WINDOW/DOOR

OSB SPACERS

HEADER W/ REQUIRED

2"X4" STUD WALL @ 16" O.C. -

READING NOOK AREA

W/ REQUIRED OSB SPACERS

MIN. R-38 CEILING

3/4" TOUNGUE &

PLYWOOD LOFT

GROOVE

SUB FLOOR

(2) 2"X6" LOFT

BAND JOISTS

1ST FLOOR

SUB FLOOR

2"X12" P.T.

2"X7" P.T. SOLE PLATE FASTENED :

TO STEEL BEEM

W/ 1/2" ΦBOLTS

FASTENERS

@ 24" O.C.

(GALVANIZED) OR

POWDER ACUATED

W16X36 @ 28' STEEL

STEEL BEAM PRIMED & PAINTED TO PROTECT

FROM CORROSION

BEAM PER PLAN

JOIST -

RUBBERIZED ASPHALT

ROLL FLASHING ON TOP

OF ALL EXPOSED P.T. BAND JOIST -

INSULATION

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S.5.4

DETAILS 1

GENERAL TREE ATTACHMENT BOLT (TAB) #1 & #2 NOTES:

CAPACITY

- HEAVY LIMB TREE ATTACHMENT BOLT (HL-TAB) #1 & HEAVY LIMB TREE ATTACHMENT BOLT (HL-TAB) #2 ARE SHOWN ON SHEET TBF.1
- CONSULTATION AND DIRECTION PROVIDED BY DARYL MCDONALD FROM NELSON TREEHOUSE AND SUPPLY (TREEHOUSE MASTERS) ON TABS AND ADDITIONAL HARDWARE NEEDED FOR PROPER TREE STRUCTURE. MARCEL PAPINEAU, P.E. WAS PRESENT DURING A PHONE CALL CONFERENCE WHEN DETERMINING HARDWARE NEEDED.

HEAVY LIMB - TREE ATTACHMENT BOLT (TAB) #1 & #2 NOTES:
• HL (HEAVY LIMB) TAB SUPPORTS 20000LBS ALLOWABLE LOAD

• HL DYNAMIC UPLIFT ARRESTOR USED TO ATTACH THE BEAM

• HL TAB SUSPENSION SYSTEM USED AS ADDITIONAL SUPPORT

AT THE END OF THE TAB (LOWER RIGHT REFERENCE IMAGE)

TO THE TAB (LOWER RIGHT REFERENCE IMAGE)

STANDARD LIMB TREEHOUSE ATTACHMENT BOLT (SL-TAB)

N.T.S. (ILLUSTRATION PURPOSES ONLY - HL TABS WILL BE USED)

Daryl McDonald Nelson Treehouse and Supply (Treehouse Masters) PO Box 1135 Fall City, WA 98024 www.nelsontreehouse.com

coarse threading to

secure into tree





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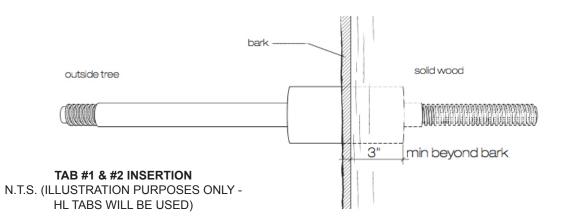
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HEAVY LIMB TREE ATTACHMENT BOLT (HL-TAB)

N.T.S. (ILLUSTRATION PURPOSES ONLY)



threaded end for hex nut or "k-nut" 6" 51/2" into tree



TREE ATTACHMENT BOLT, DYNAMIC UPLIFT ARRESTOR & SUSPENSION SYSTEM

N.T.S. (ILLUSTRATION PURPOSES ONLY - STEEL I BEAM TO BE USED INSTEAD OF WOOD I BEAM SHOWN)





* THE DYNAMIC UPLIFT ARRESTOR WILL EITHER BE WILLDED TO THE BOTTOM OF THE STEEL BEAM OR FASTENED WITH (2) 3/4" \$\phi\$ A325 GREENED DOWN Lincoln County

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S.5.5

DETAILS 2

ROUGH OPENINGS FOR VINYL WINDOWS								
SINGLE WINDOW UNITS								
QUANTITY	CALL SIZE	ACTUAL SIZE	ROUGH OPENING					
(1ST FLOOR)			SIZE					
3	4-0 X 4-0	47 1/2" X 47 1/2"	48" X 48"					
1	1-6 X 3-0	17.5" X 35.5"	18" X 36"					
(LOFT)								
2	4-0 X 4-0	47 1/2" X 47 1/2"	48" X 48"					
2	2-0 X 3-0	23.5" X 35.5"	24" X 36"					
3	3-0 X 2-0	35.5" X 23.5"	36" X 24"					

ROUGH OPENINGS FOR PLEXIGLASS WINDOWS
SINGLE WINDOW UNITS

15.5" X 35.5"

15.5" X 49.5"

CALL SIZE | ACTUAL SIZE | ROUGH OPENING

SIZE

16" X 36"

16" X 50"

QUANTITY

(1ST FLOOR)

(LOFT)

1-4 X 3-0

1-4 X 4-1

ROUGH OPENINGS FOR VINYL ENTRY DOOR							
SLIDING GLASS DOOR							
QUANTITY	CALL SIZE	ACTUAL SIZE	COMMON				
(1ST FLOOR)							
1	6-0 X 6-8	70.75" X 79.5"	72" X 80"				

ROUGH OPENINGS FOR FIBERGLASS ENTRY DOOR								
INSWING UNIT								
QUANTITY	CALL SIZE	ACTUAL SIZE	ROUGH OPENING					
(1ST FLOOR)			SIZE					
1	2-0 X 6-8	24" X 80"	26" X 82"					





STEEL I BEAMS											<u> </u>		
STATIC PARAMETERS													
MOMENT OF INERTIA ELASTIC SECTION MODULUS													
BEAM#	CUT	DESIGNATION	DEPTH	WIDTH	WEB THICKNESS	FLANGE THICKNESS	SECTIONAL	WEIGHT	I _x	I _Y	S _x	S _Y	BOTH BEAMS
	LENGTH	IMPERIAL	н	w	T _w	$T_{_{F}}$	AREA	(LB _F /FT)	(IN ⁴)	(IN⁴)	(IN³)	(IN³)	PRIMED &
		(IN X LB/FT)	(IN)	(IN)	(IN)	(IN)	(IN ²)						PAINTED TO
1	28'	W 16 X 36	15.86	6.985	0.295	0.430	10.6	36	448	24.5	56.5	7	PROTECT FROM
2	23'	VV 10 X 30	13.00	0.303	0.293	0.430	10.0	30	440	24.5	30.5	·	CORROSION

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Sheet Number:

S.6

SCHEDULE DETAILS